




MIN. 1 SHEET METAL DOWNSPOUT FOR EACH 100 FEET OF GUTTER  
CONNECT RAIN WATER LEADERS TO STORM SEWER SYSTEM OR  
PROVIDE CONCRETE SPLASH PADS TO PREVENT SOIL EROSION.

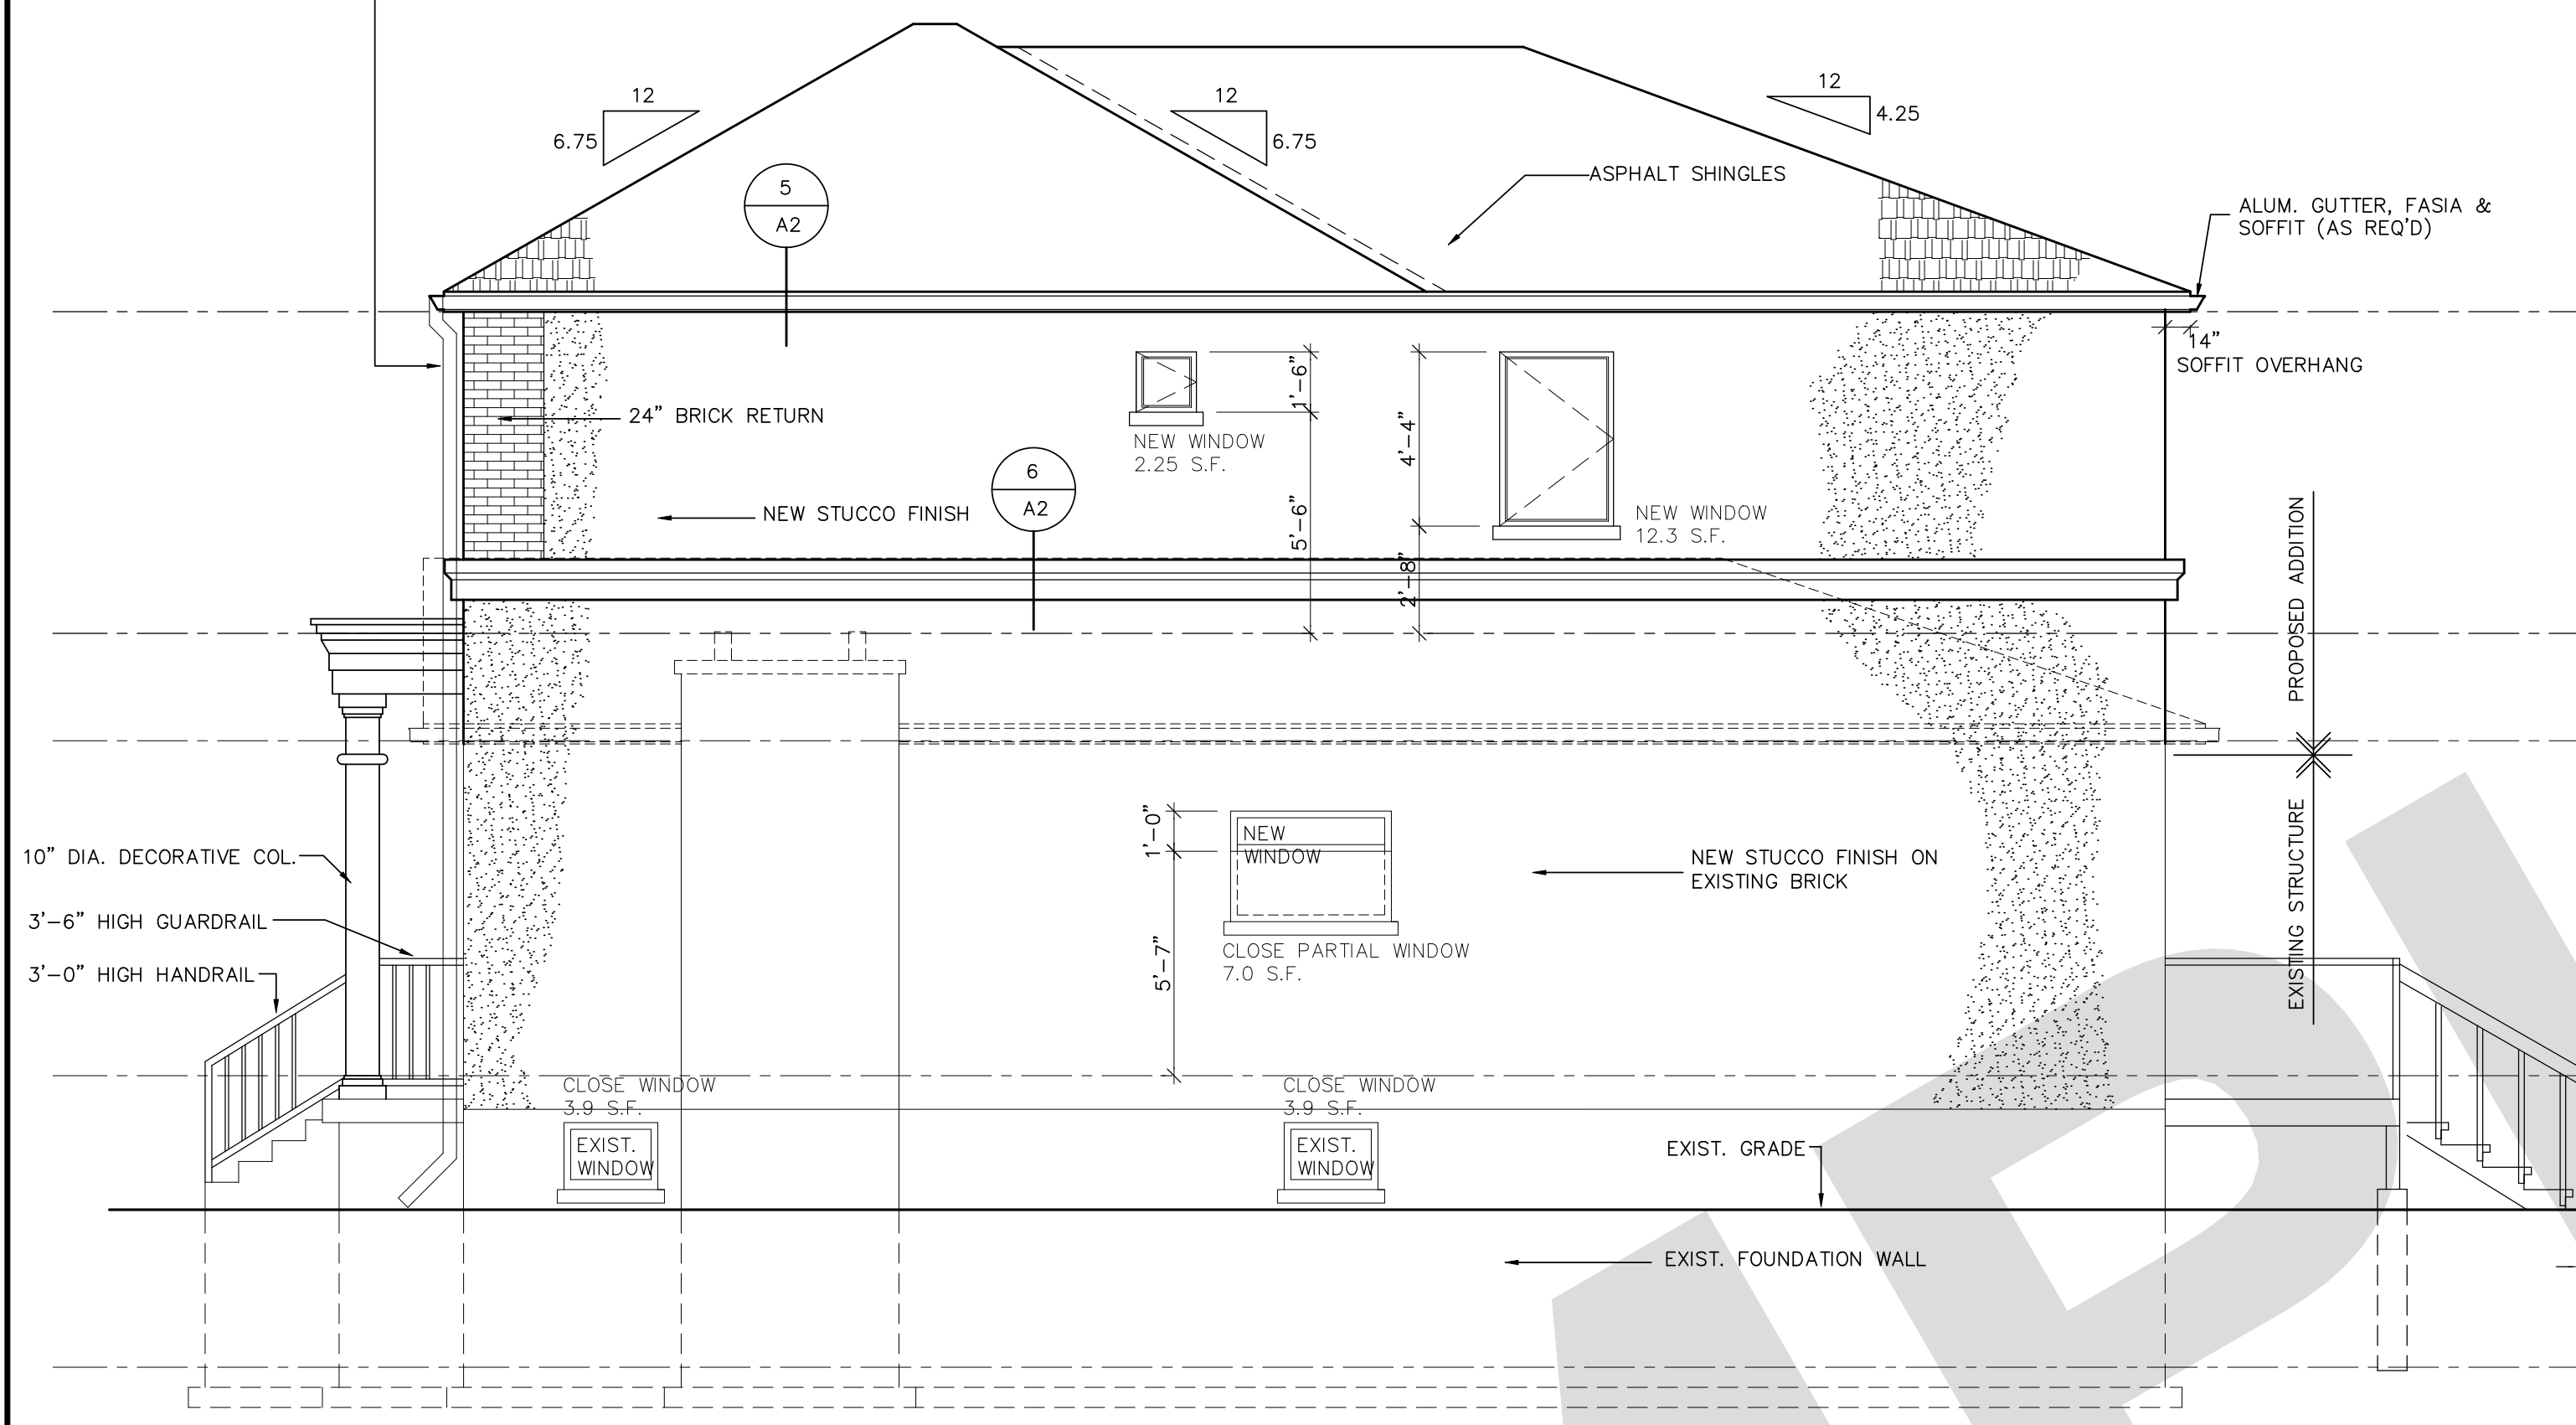


1 PROPOSED WEST ELEVATION  
A3 1/4"=1'-0"

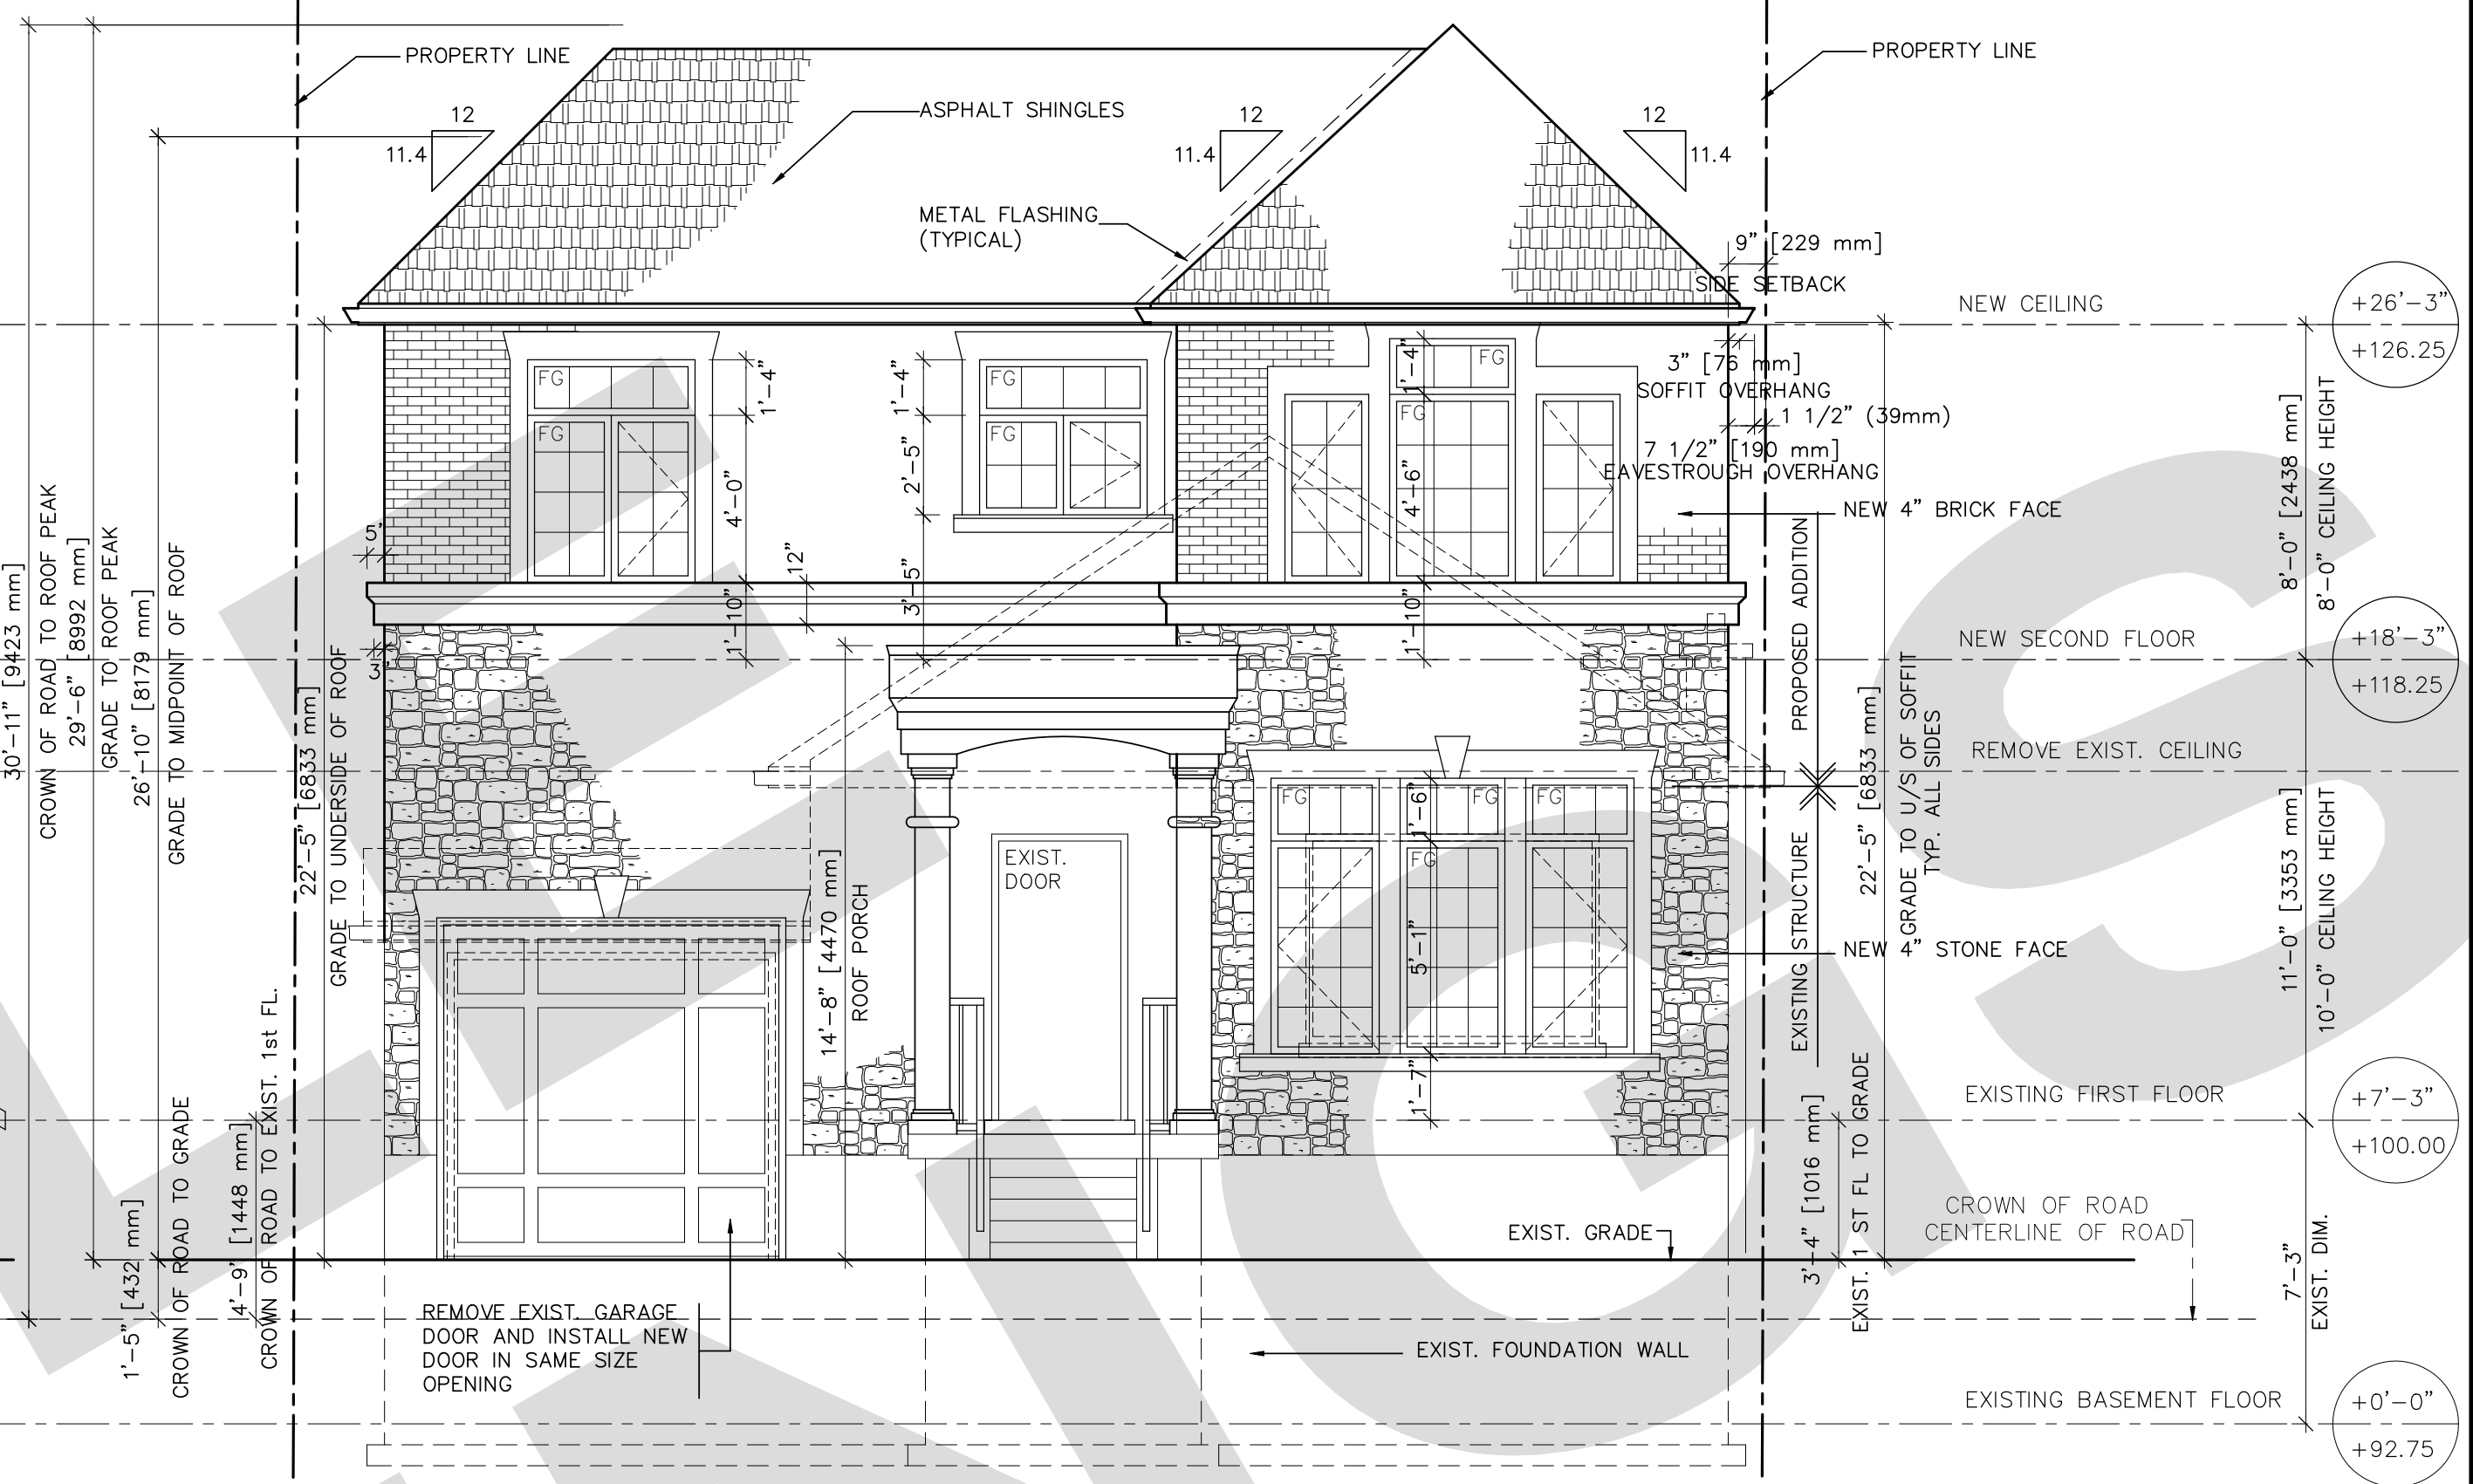

2 PROPOSED NORTH ELEVATION  
A3 1/4"=1'-0"

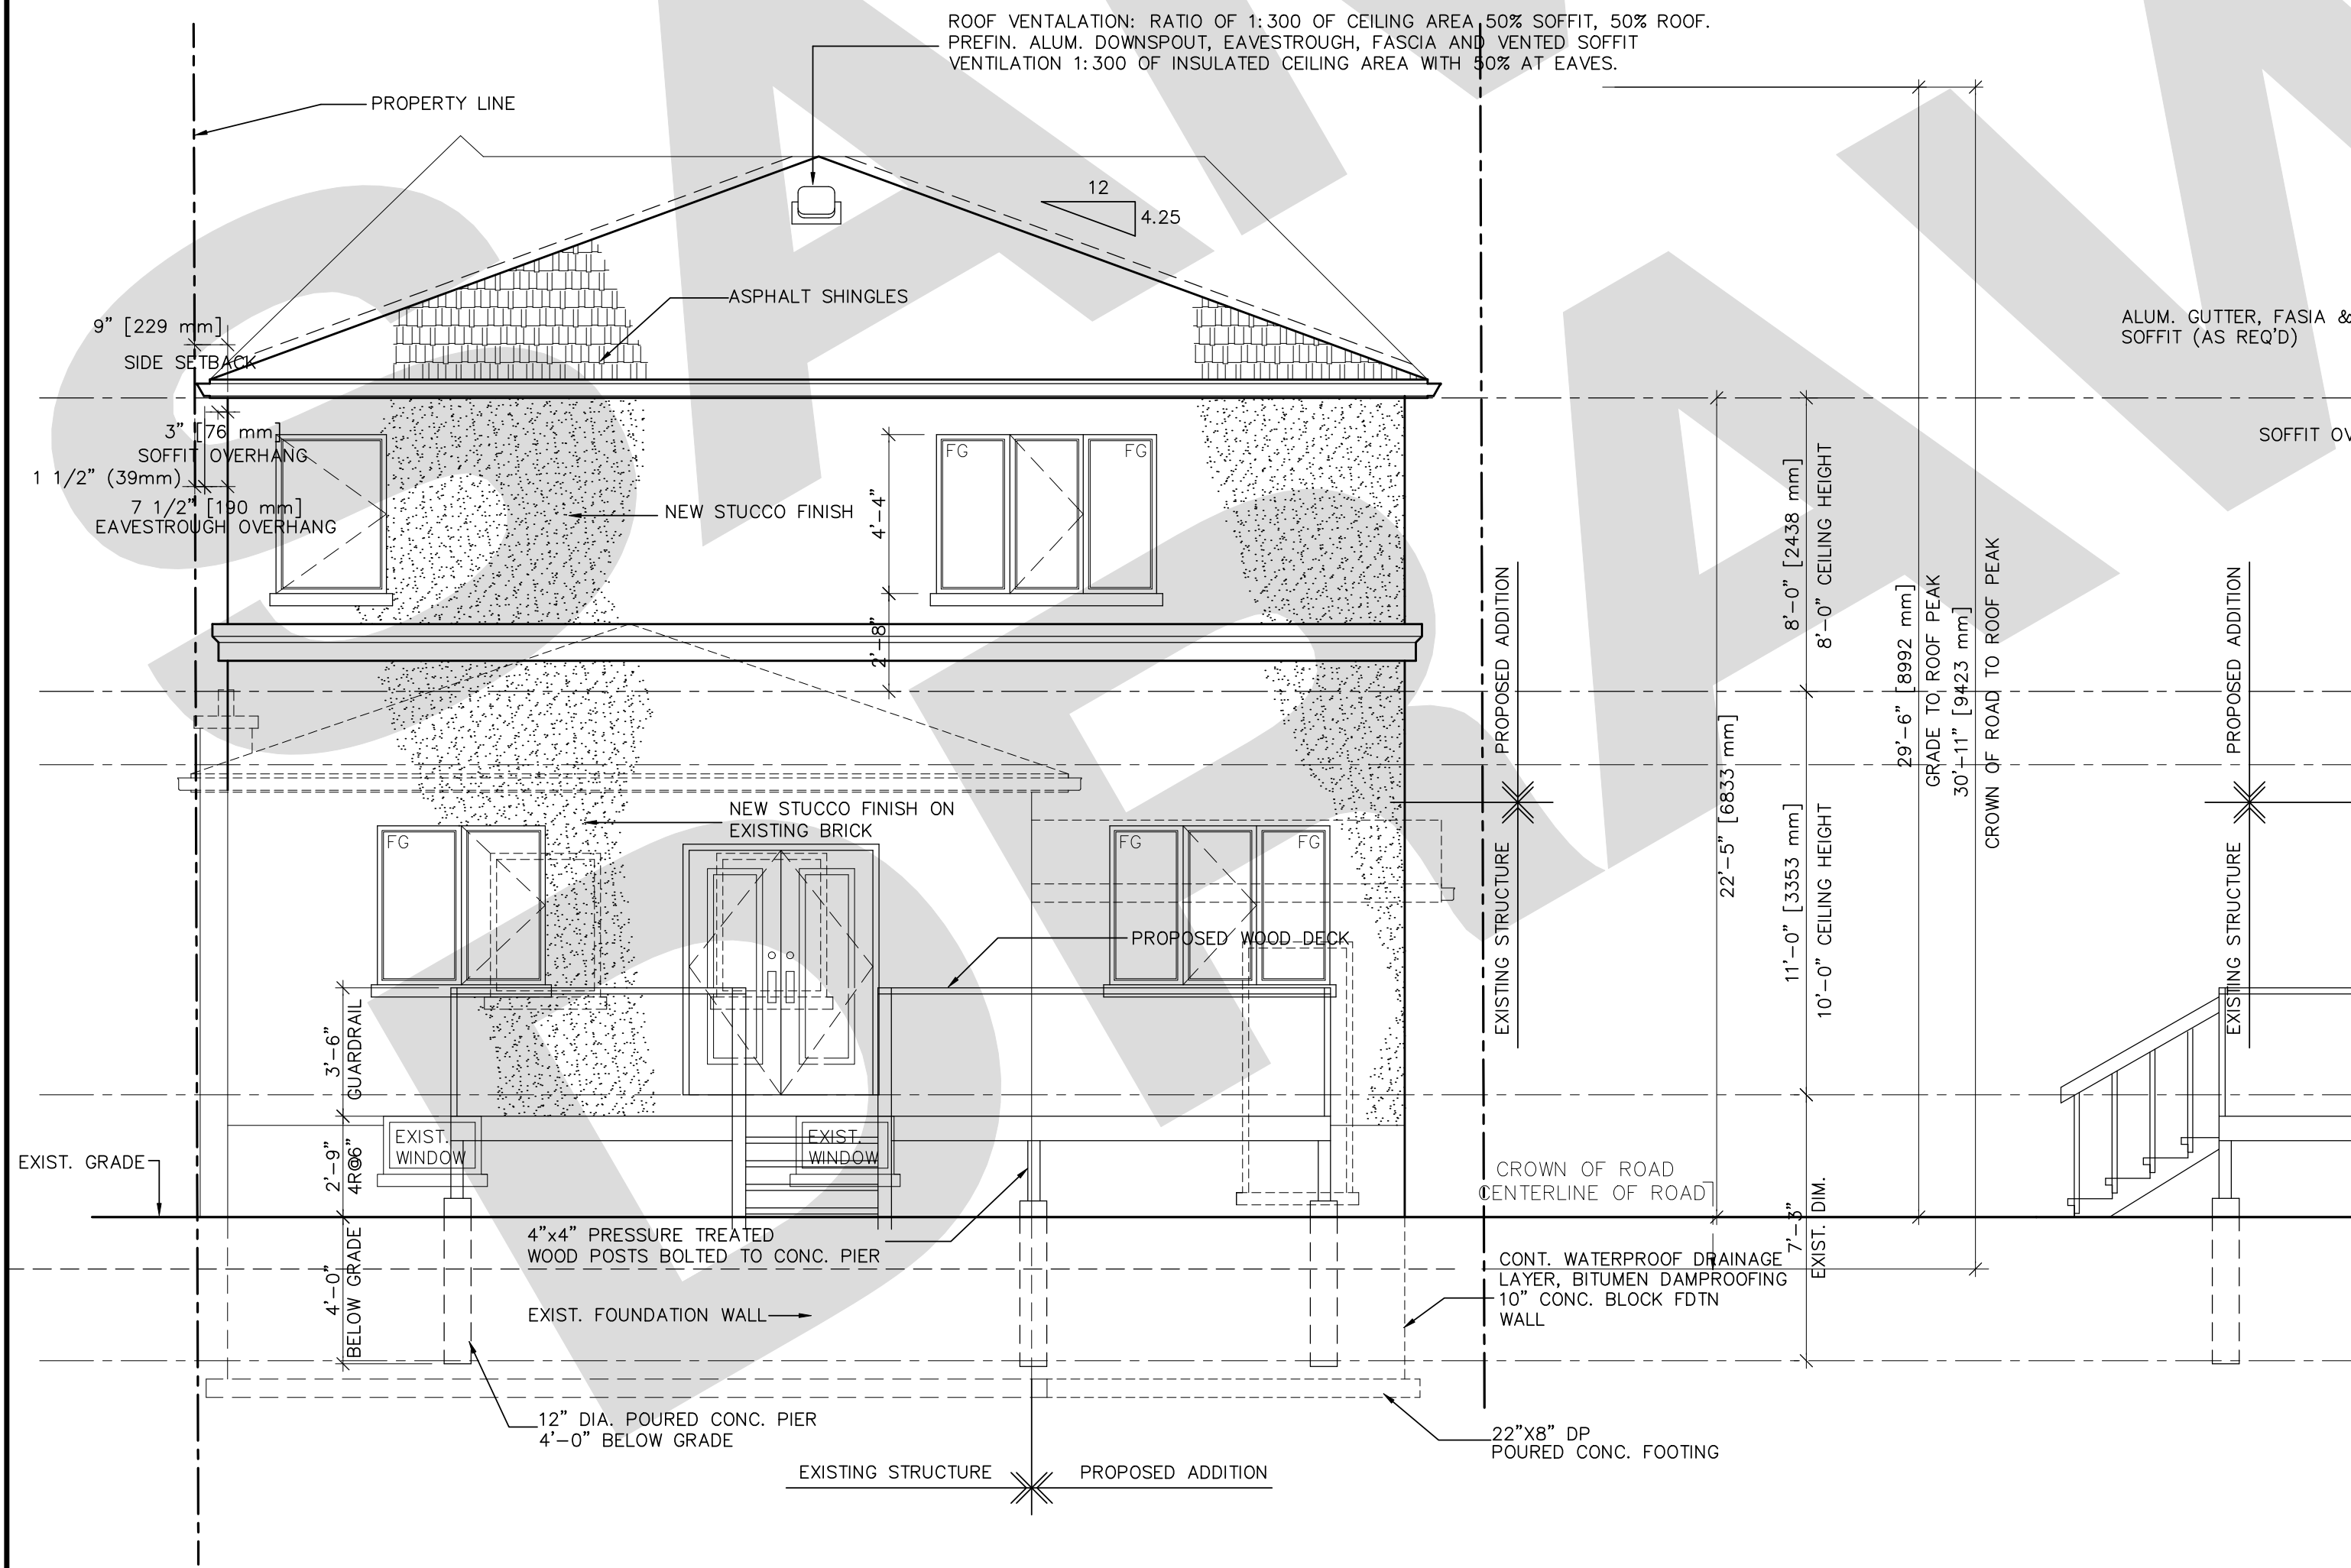

3 PROPOSED SOUTH ELEVATION  
A3 1/4"=1'-0"

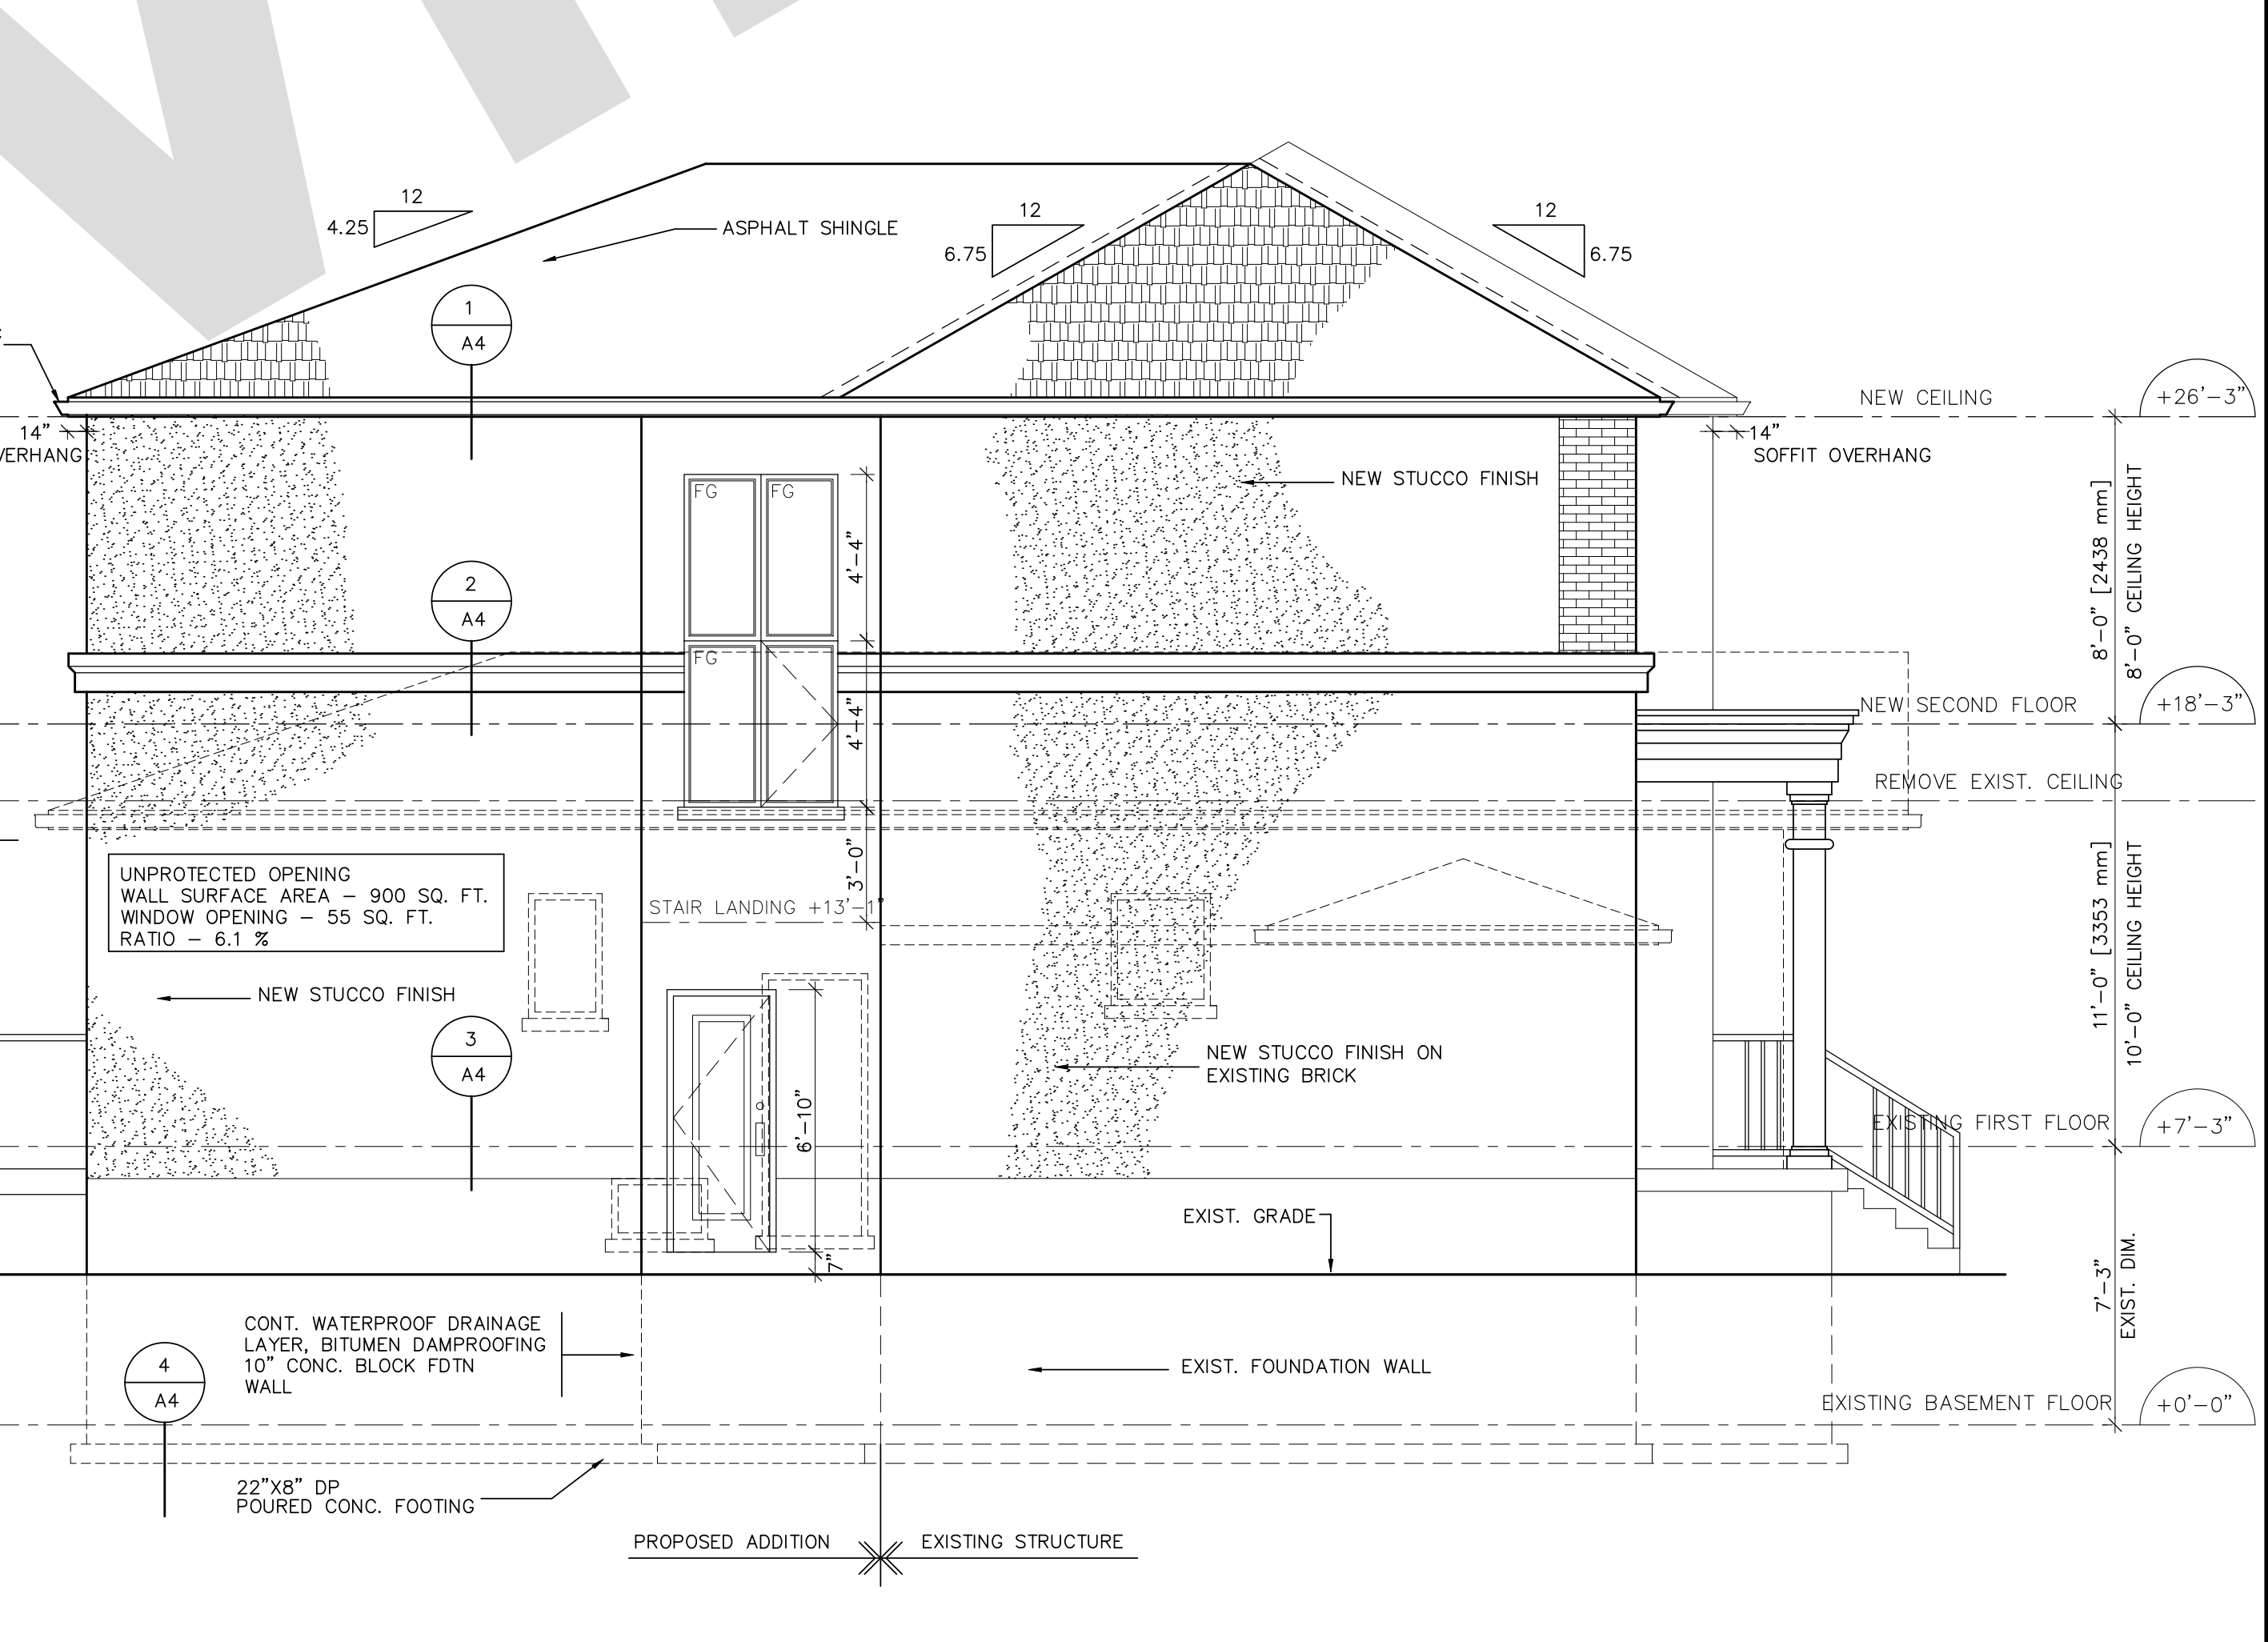

4 PROPOSED EAST ELEVATION  
A3 1/4"=1'-0"

REVISIONS				
NO.	DATE	ISSUED	BY	CHKD

THIS DRAWING SHALL NOT BE COPIED, REPRODUCED OR DISTRIBUTED IN ANY MANNER WITHOUT THE EXPRESS WRITTEN APPROVAL OF THE DESIGNER. THE CONTRACTORS SHALL VERIFY ALL DIMENSIONS ON THE JOB AND REPORT ANY DISCREPANCY TO THE DESIGNER PRIOR TO PROCEEDING WITH THE WORK. ALL DRAWINGS AND SPECIFICATIONS ARE THE PROPERTY OF THE DESIGNER AND SHALL BE RETURNED UPON COMPLETION OF THE CONSTRUCTION WORK.



PROJECT  
**PROPOSED SECOND STOREY ADDITION FOR**

TORONTO ONTARIO

**EXTERIOR ELEVATIONS**

DATE JULY 21 2014	DATE PRINTED CHECKED	PROJECT FILE
DRAWN S.J.P.	SCALE 1/4"=1'-0"	
SHEET NO.		<b>A3 of 4</b>